



WATER AND SANITATION DEVELOPMENT PROJECT

IMPROVEMENT OF COMMUNAL ONSITE SANITATION FACILITIES FOR WAJIR PROJECT AREA

VOLUME III:- DRAWINGS



East African Engineering Consultants Ltd.
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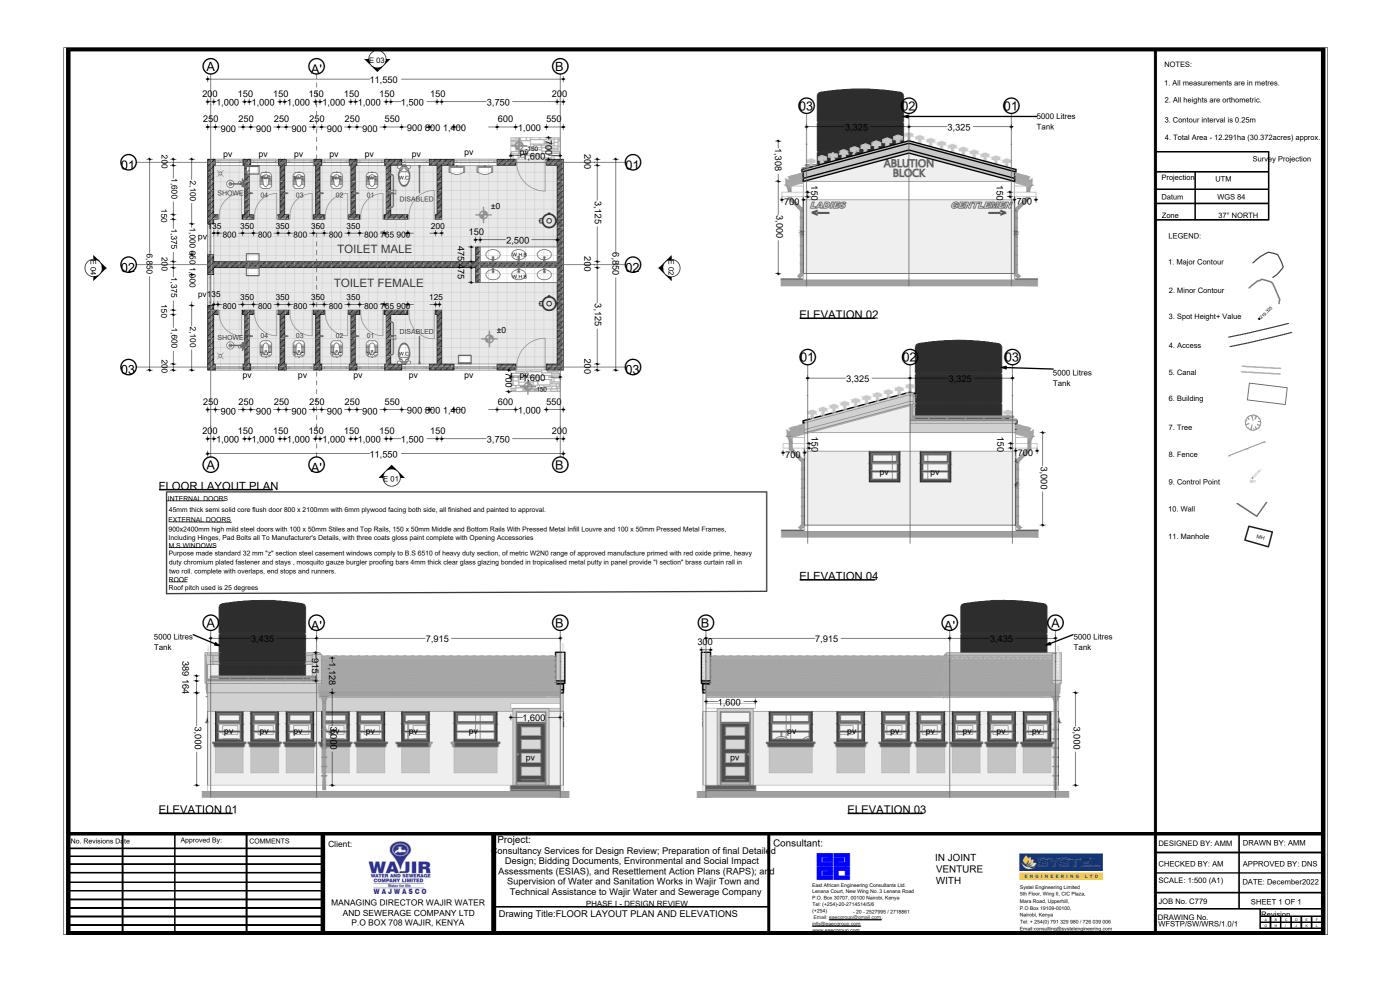
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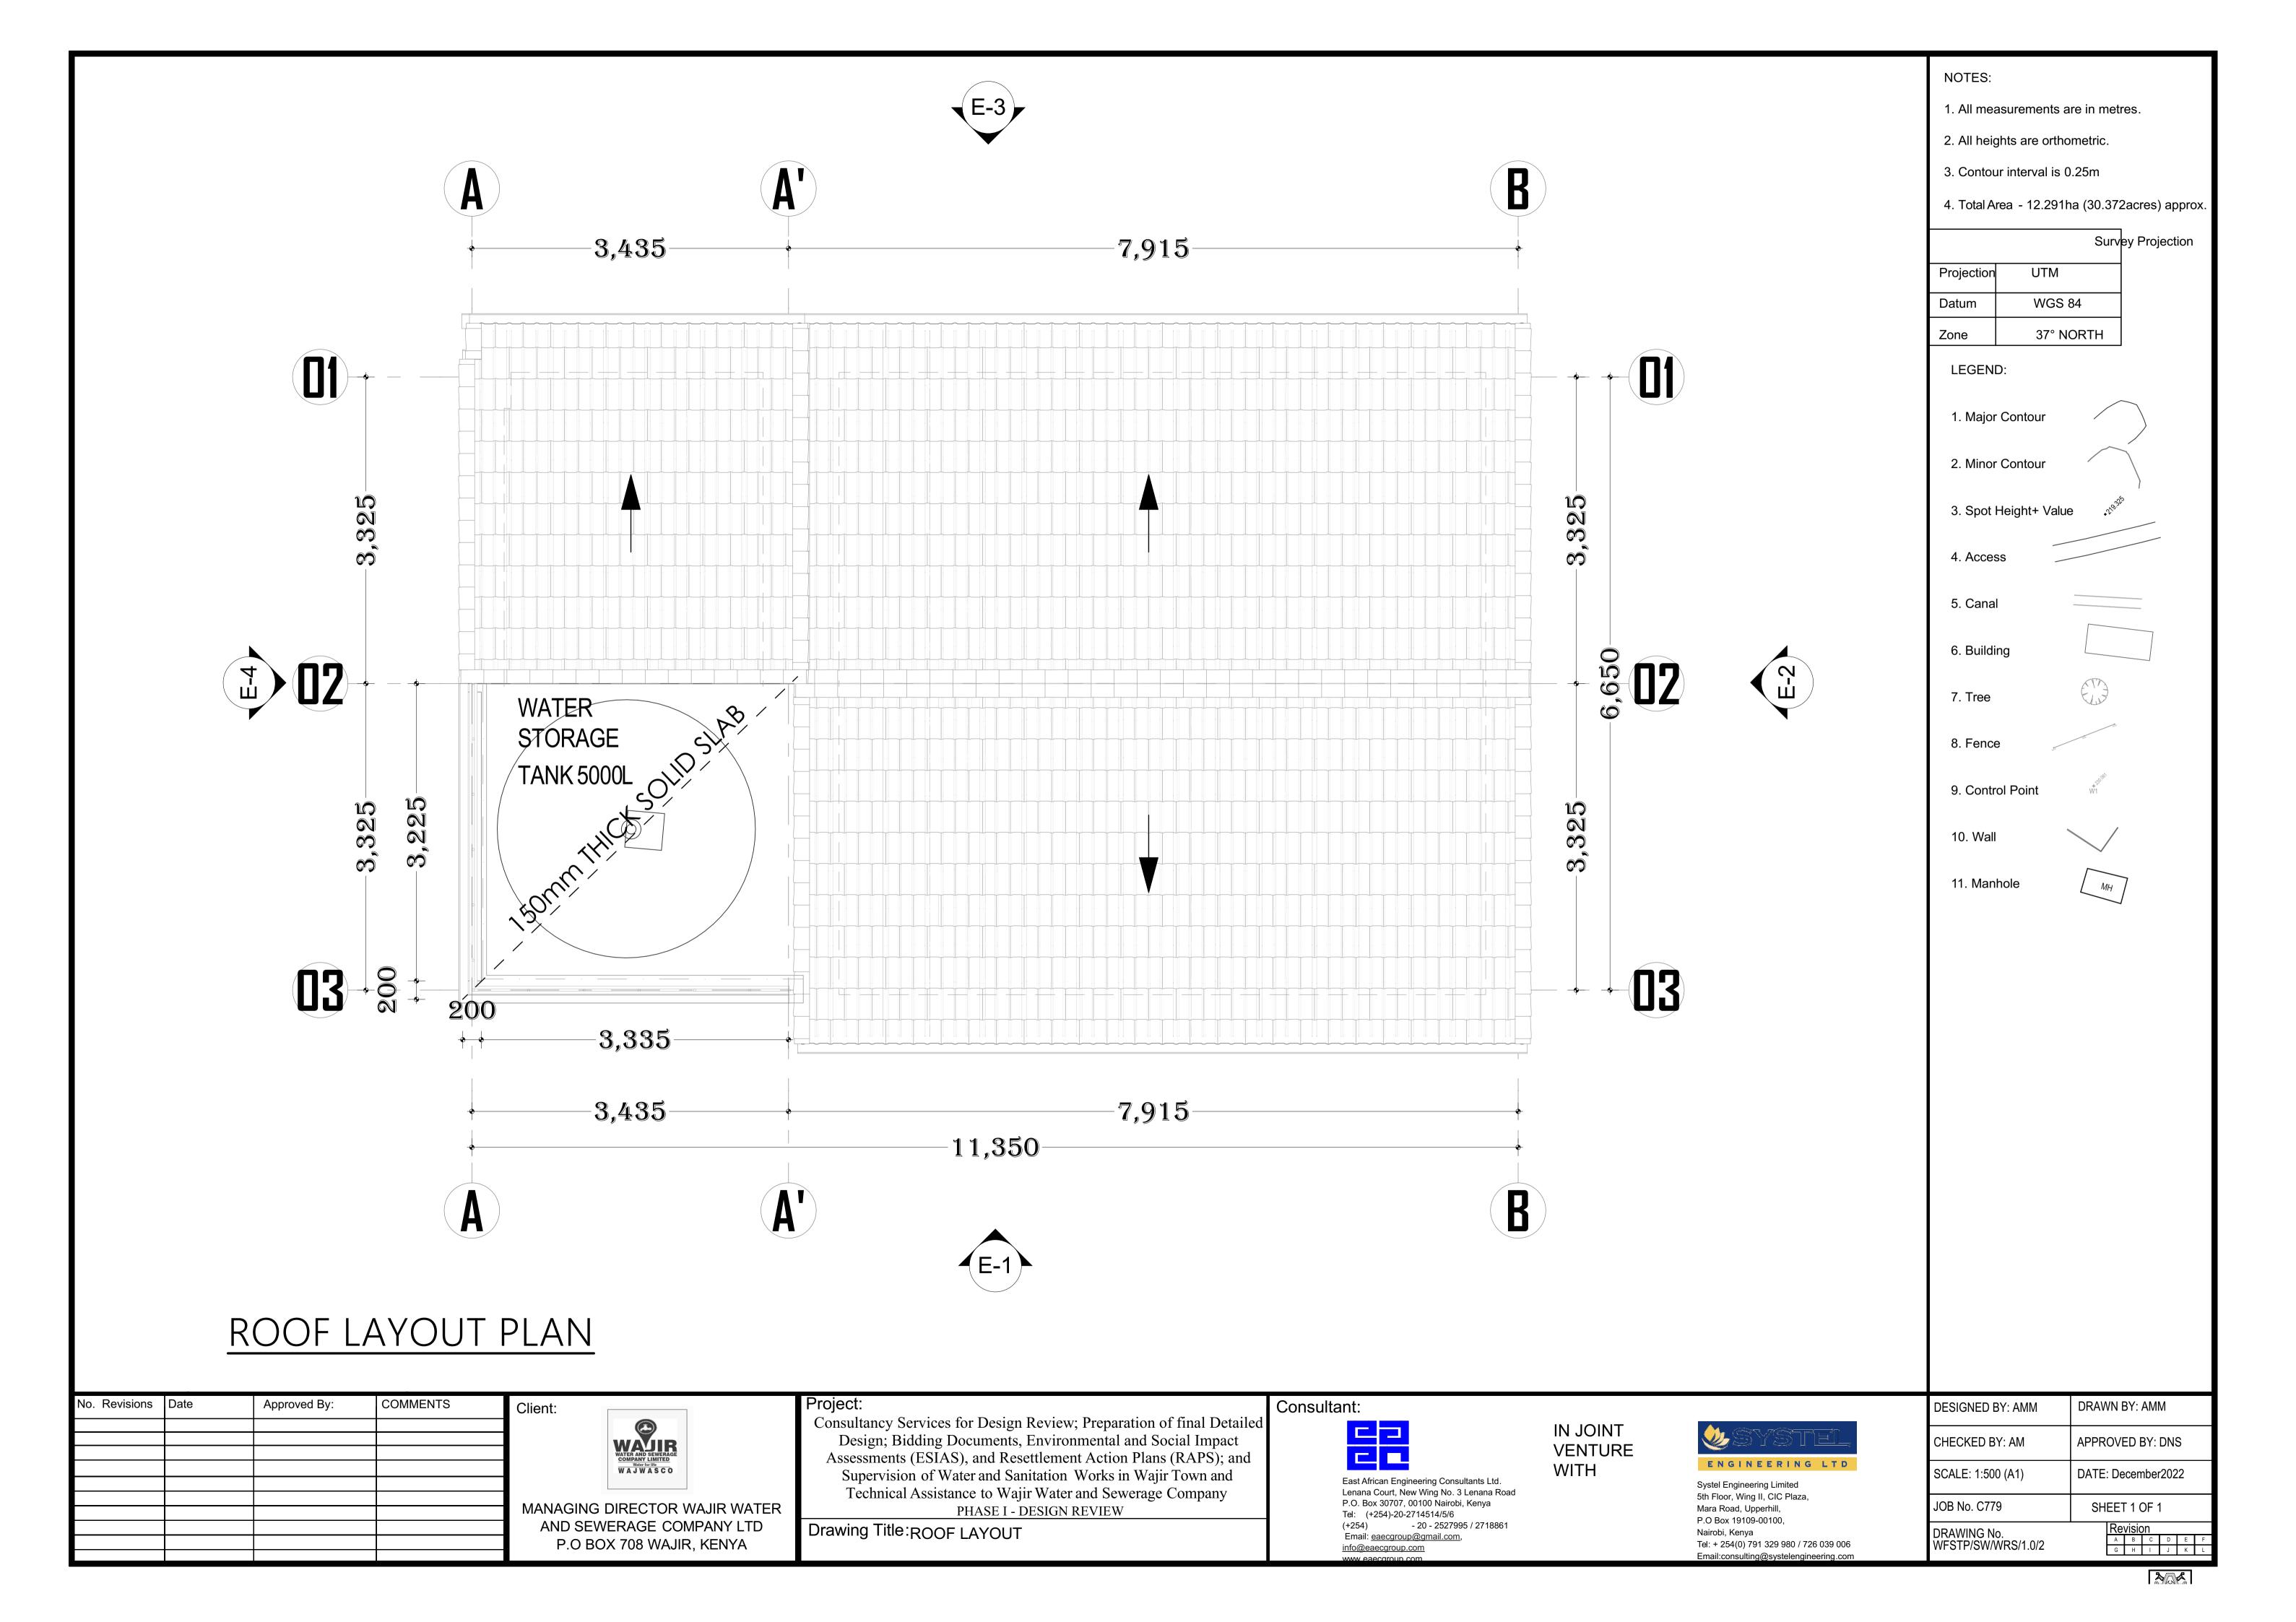
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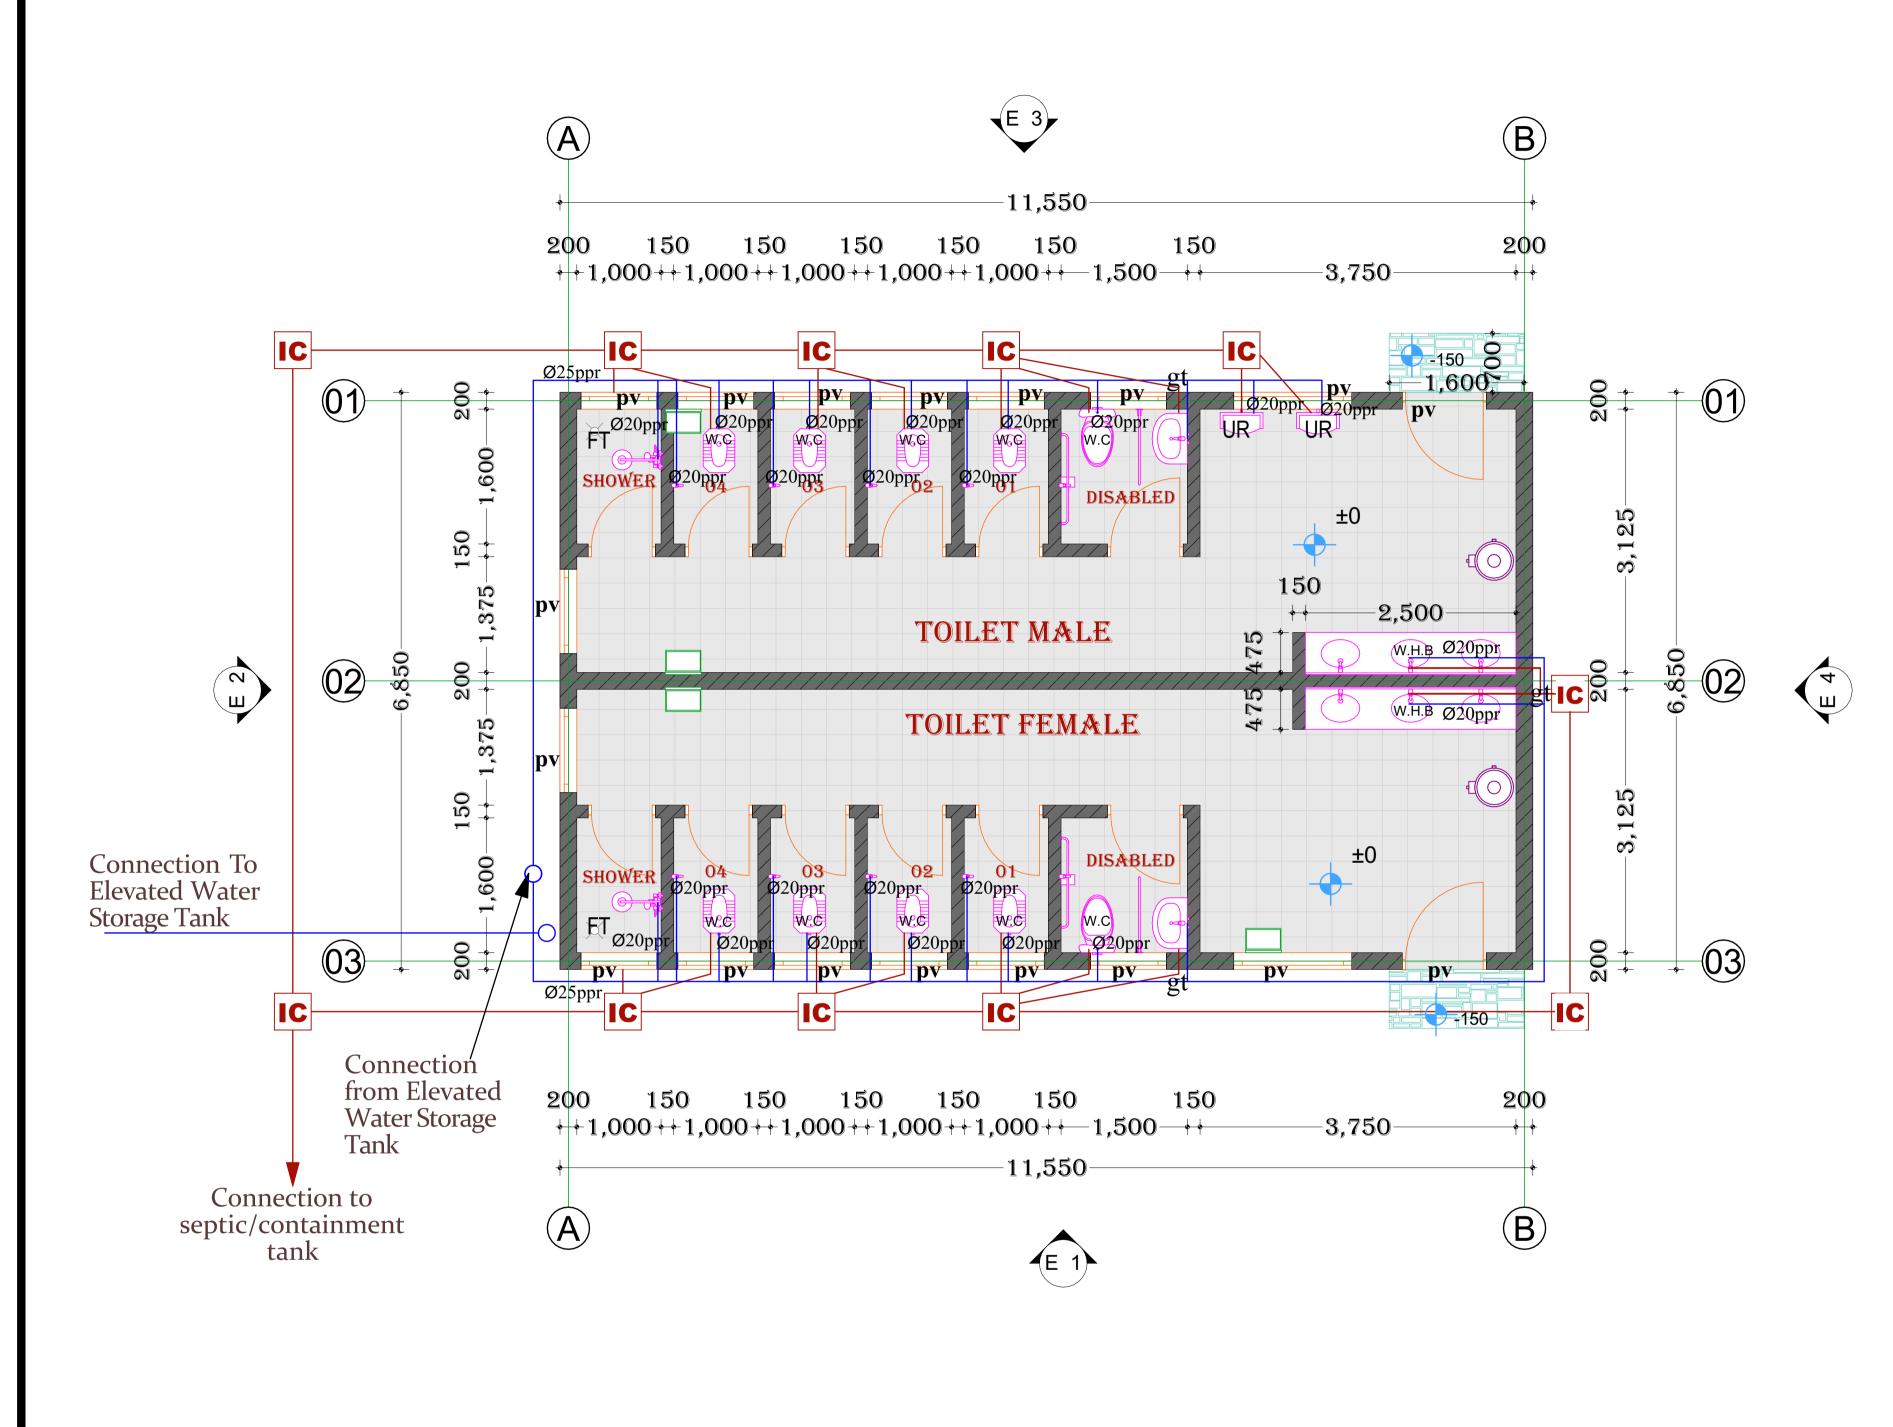
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NO	NORMALLY OPEN
NPW	NON-POTABLE WATER
OD	OUTSIDE DIAMETER
OS&Y	OUTSIDE SCREW & YOKE GATE VALVE
OST	OVERFLOW STORM
FT	FLOOR TRAP
GT	GULLEY TRAP
PRV	PRESSURE REDUCING VALVE
PSI	POUNDS PER SQUARE INCH
PSIG	
RISE	POUNDS PER SQUARE INCH (GAUGE)
SA	RISE (WITH IN FLOOR) SHOCK ABSORBER
SAN	SANITARY
SD	SMOKE DETECTOR
SF	SQUARE FEET
SK	SINK
ST	STORM PIPING
TD	TRENCH DRAIN
TDH	TOTAL DISCHARGE HEAD
TMV	TEMPERATURE MIXING VALVE
TOP	TOP OF PIPE
TOS	TOP OF SLAB
TP	TRAP PRIMER
TPV	TRAP PRIMER VALVE
TS	TAMPER SWITCH
TYP	TYPICAL
UON	UNLESS OTHERWISE NOTED
UP	UP (PENETRATES FLOOR SLAB)
UR	URINAL
V	VENT
VB	VACUUM BREAKER
VR	VENT RISE
VTR	VENT THROUGH ROOF
WC	WATER CLOSET
WCO	WALL CLEANOUT
WHB	WALL HAND BASIN
WF	WATER FILTER
WFU	WATER FIXTURE UNIT

- 1. All measurements are in metres
- 2. All heights are orthometric.
- 3. Contour interval is 0.25m
- 4. Total Area 12.291ha (30.372acres) approx.

	Surv	ey Projection
Projection	UTM	
Datum	WGS 84	
Zone	37° NORTH	

LEGEND:

1. Major Contour

2. Minor Contour

3. Spot Height+ Value

4. Access

5. Canal

6. Building

7. Tree

8. Fence

9. Control Point

11. Manhole

MH

PIPING LEGEND		
	COLD WATER PIPING	
	SOIL VENT PIPE	
IC	INSPECTION CHAMBER	
	COLD WATER PIPING WITH CONNECTION TO ABOVE	

PLUMBING LAYOUT PLAN [FOUL WATER AND CLEAN WATER FOR USE]

MANAGING DIRECTOR WAJIR WAAND SEWERAGE COMPANY LT	No. Revisions	Date	Approved By:	COMMENTS	Client:
MANAGING DIRECTOR WAJIR WA AND SEWERAGE COMPANY LT					WAJIR
AND SEWERAGE COMPANY LT					
P.O BOX 700 WAJIR, KEINTA					AND SEWERAGE COMPANY LT P.O BOX 708 WAJIR, KENYA

Project:

Consultancy Services for Design Review; Preparation of final Detailed Design; Bidding Documents, Environmental and Social Impact Assessments (ESIAS), and Resettlement Action Plans (RAPS); and Supervision of Water and Sanitation Works in Wajir Town and Technical Assistance to Wajir Water and Sewerage Company PHASE I - DESIGN REVIEW

Drawing Title: PLUMBING LAYOUT

Consultant:

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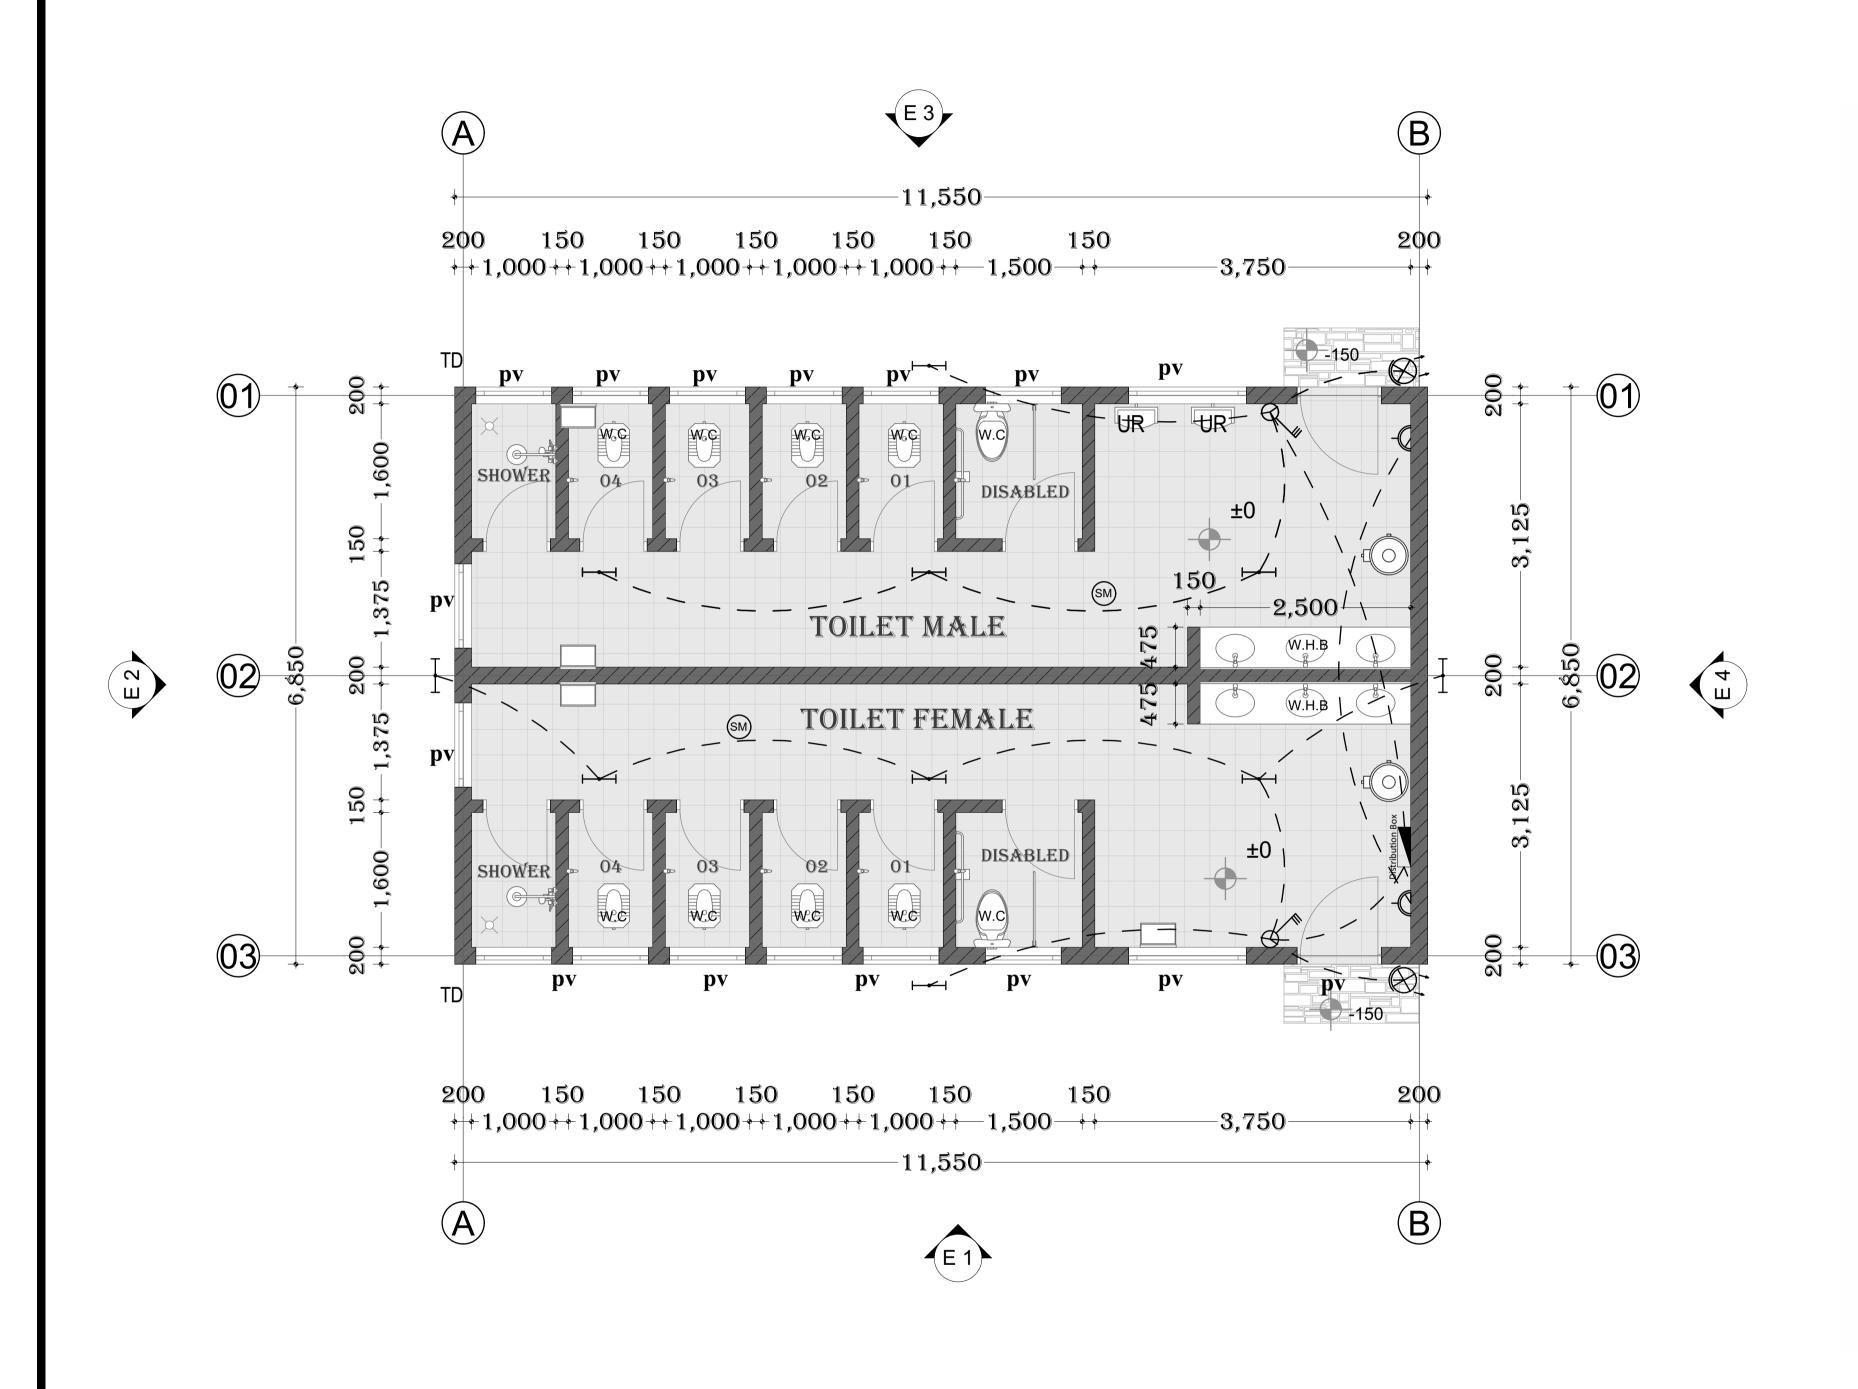
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IN JOINT VENTURE WITH



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SCALE: 1:500 (A1)	DATE	: Ju	ne2	023			
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DRAWING No.			visio	n		-	_
WFSTP/SW/WRS/1.0/3		A G	B H	I	J	E K	F



REFLECTED CEILING & ELECTRICAL PLAN LEGEND: CH 0'=0' INDICATES CEILING HEIGHT Switch 3 Poles One Way SURFACE MOUNTED OR PENDANT LIGHT FIXTURE ("EX" INDICATES EXTERIOR FIXTURE & "P" INDICATES POST FIXTURE) SURFACE MOUNTED FAN W/ LIGHT FIXTURE RECESSED POT LIGHT ("WP" INDICATES WATERPROOF) -·--- RECESSED OR SURFACE MOUNTED STRIP LIGHT Socket Outlet Multiple 2 Gangs SURFACE MOUNTED DECORATIVE WALL SCONCE ("EX" SURFACE MOUNTED LED WALL LIGHT FIXTURE (TO BE LOCATED ABOVE DOOR OPENING ON CENTER OF OPENING) FAN EXHAUST FAN SMOKE ALARM Fluorescent Lighting WALL MOUNTED DUPLEX OUTLET TO BE LOCATED AS PER O.B.C. UNLESS OTHERWISE NOTED. "AC" REPRESENTS "ABOVE COUNTER", "EX" - EXTERIOR OUTLET LOCATED IN MILLWORK. REFER TO MILLWORK DETAILS FOR CLARIFICATION (ID-500'S) WALL MOUNTED DUPLEX OUTLET WITH GROUND FAULT TO BE LOCATED AS PER O.B.C. UNLESS OTHERWISE NOTED. "AC" REPRESENTS "ABOVE COUNTER". Spot Light Symbol WALL MOUNTED CABLE OUTLET AND RECESSED BOX FOR OUTLET & CABLE CONNECTION TO BE LOCATED AS SPECIFIED Distribution Box REFLECTED CEILING & ELECTRICAL PLAN NOTES:

1. REFER TO INTERIOR DESIGN LIGHTING SCHEDULE FOR ALL LIGHTING 7 2. GENERAL CONTRACTOR & ELECTRICIAN TO REVIEW DRAWINGS FOR ANY DISCREPANCIES. ANY DRAWING DISCREPANCIES SHALL BE BROUGHT TO THE ATTENTION OF THE INTERIOR DESIGN CONSULTANT PRIOR TO CONSTRUCTION. 3. ALL ELECTRICAL SWITCHES TO BE LOCATED 42" OC. AFF. UNLESS OTHERWISE NOTED. SWITCH LOCATIONS TO BE CONFIRMED WITH CLIENT & INTERIOR DESIGN CONSULTANT PRIOR TO INSTALLATION. CONSULTANT & CLIENT PRIOR TO SWITCH INSTALLATION. 6. DIMENSIONS ARE TAKEN FROM CENTER OF LIGHT FIXTURES, UNLESS OTHERWISE NOTED. 5. ALL LIGHT FIXTURES SHOWN CENTERED ON REFLECTED CEILING PLAN TO B LOCATED CENTERED ON SITE, UNLESS OTHERWISE NOTED 6. FIXTURE QUANTITIES TO BE VERIFIED BY INSTALLER PRIOR TO ORDERING 7. ALL DECORATIVE SURFACE MOUNTED FIXTURES TO BE SPECIFIED OR SUPPLIED BY CLIENT TO BE INSTALLED BY ELECTRICIAN 8. ALL WALL SCONCES TO BE LOCATED AS PER INTERIOR DESIGN DRAWINGS. 9. DIMENSIONS ARE TAKEN FROM THE CENTER OF OUTLETS, UNLESS OTHERWISE NOTED. 10.ALL OUTLETS TO BE LOCATED ON CENTER (O.C.), OF WALL UNLESS 11.ALL WALL MOUNTED ELECTRICAL OUTLETS & SWITCHES ARE TO BE "DECORA" UNLESS OTHERWISE NOTED. FINISH AS SPECIFIED. 12.ALL ABOVE COUNTER OUTLETS TO BE LOCATED 42" OC. AFF. UNLESS. 13.SECURITY ALARM, AUDIO/VISUAL & HOME AUTOMATION COMPONENT LOCATIONS TO BE CONFIRMED WITH CLIENT & ALL OTHER CONSULTANTS PRIOR TO INSTALLATION. 14.ALL OUTLETS PLACED TOGETHER TO BE GANGED INTO SINGLE ROUGH IN BOX WITH ONE COVER PLATE AS REQUIRED. SPECIFIC MOUNTING HEIGHTS TO BE INDICATED ON INTERIOR DESIGN ELECTRICAL PLANS. 15. ELECTRICAL, MECHANICAL & STORAGE ROOM EQUIPMENT/ELECTRICAL AS PER TRADE REQUIREMENT & O.B.C., DOCUMENT INDICATING ON SITE LOCATION TO BE PROVIDED TO INTERIOR DESIGN CONSULTANT. 16.ALL AREAS WHERE CABINETRY IS TO HAVE ELECTRICAL TO BE FINALIZED ONCE MILLWORK SHOP DRAWINGS ARE REVIEWED. 17.ALL SWITCHING TO BE CONVENTIONAL UNLESS OTHERWISE NOTED. 18.EXTERIOR OUTLET LOCATIONS TO BE CONFIRMED WITH LANDSCAPE (

NOTES:

- 1. All measurements are in metres.
- 2. All heights are orthometric.
- 3. Contour interval is 0.25m
- 4. Total Area 12.291ha (30.372acres) approx.

Survey Projection

Projection	UTM
Datum	WGS 84
Zone	37° NORTH

LEGEND:

1. Major Contour

2. Minor Contour

3. Spot Height+ Value

4. Access

5. Canal

6. Building

7. Tree

8. Fence

9. Control Point

11. Manhole

ELECTRICAL LAYOUT PLAN

No. Revisions	Date	Approved By:	COMMENTS	Client:	
					WALIB
					WATER AND SEWERAGE COMPANY LIMITED Water for life WA J W A S C O
					WAJWASCO
				MANAGING	DIRECTOR WAJIR WATER
				AND SEW	ERAGE COMPANY LTD
				P.O BO	X 708 WAJIR, KENYA

Project:

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PHASE I - DESIGN REVIEW Drawing Title:ELECTRICAL LAYOUT

Consultant:

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CHECKED BY: AM	APPROVED BY: DNS
SCALE: 1:500 (A1)	DATE: December2022
JOB No. C779	SHEET 1 OF 1
DRAWING No. WFSTP/SW/WRS/1.0/4	Revision A B C D E G H I J K



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Survey Projection

Projection	UTM
Datum	WGS 84
Zone	37° NORTH

LEGEND:

1. Major Contour

2. Minor Contour

3. Spot Height+ Value

4. Access

5. Canal

6. Building

7. Tree

8. Fence

9. Control Point

11. Manhole

VIEW 01

No.	Revisions	Date	Approved By:	COMMENTS	С
-					
					ľ

Client: WATER AND SEWERAGE COMPANY LIMITED Water for life WAJWASCO

MANAGING DIRECTOR WAJIR WATER AND SEWERAGE COMPANY LTD P.O BOX 708 WAJIR, KENYA

Project:

Consultancy Services for Design Review; Preparation of final Detailed Design; Bidding Documents, Environmental and Social Impact Assessments (ESIAS), and Resettlement Action Plans (RAPS); and Supervision of Water and Sanitation Works in Wajir Town and Technical Assistance to Wajir Water and Sewerage Company PHASE I - DESIGN REVIEW

Drawing Title:VIEWS

Consultant:



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JOB No. C779	SHEET 1 OF 1
DRAWING No.	Revision
WFSTP/SW/WRS/1.0/v	A B C D E G H I J K



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- 2. All heights are orthometric.
- 3. Contour interval is 0.25m
- 4. Total Area 12.291ha (30.372acres) approx.

	Surv	l ey Projection
Projection		
Datum	WGS 84	
Datum		
Zone	37° NORTH	

LEGEND:

1. Major Contour

2. Minor Contour

3. Spot Height+ Value

4. Access

5. Canal

6. Building

7. Tree

8. Fence

9. Control Point

10. Wall

11. Manhole

VIEW 02

No. Revisions	Date	Approved By:	COMMENTS	Client:
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				MANA
				AND
	I			

WAJ SEWERAGE COMPANY LIMITED Water for life WAJWASCO

MANAGING DIRECTOR WAJIR WATER AND SEWERAGE COMPANY LTD P.O BOX 708 WAJIR, KENYA Project:

Consultancy Services for Design Review; Preparation of final Detailed Design; Bidding Documents, Environmental and Social Impact Assessments (ESIAS), and Resettlement Action Plans (RAPS); and Supervision of Water and Sanitation Works in Wajir Town and Technical Assistance to Wajir Water and Sewerage Company PHASE I - DESIGN REVIEW

Drawing Title:VIEWS

Consultant:



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	Surv	ey Projection
ection	UTM	
m	WGS 84	

37° NORTH

LEGEND:

1. Major Contour

2. Minor Contour

3. Spot Height+ Value

4. Access

5. Canal

6. Building

7. Tree

8. Fence

9. Control Point

10. Wa

11. Manhole

VIEW 03

No. Revisions	Date	Approved By:	COMMENTS	С
				Ι,

Client:

WAJIR

WATER AND SEWERAGE

COMPANY LIMITED

WAJ WAS CO

MANAGING DIRECTOR WAJIR WATER AND SEWERAGE COMPANY LTD P.O BOX 708 WAJIR, KENYA Project:

Consultancy Services for Design Review; Preparation of final Detailed Design; Bidding Documents, Environmental and Social Impact Assessments (ESIAS), and Resettlement Action Plans (RAPS); and Supervision of Water and Sanitation Works in Wajir Town and Technical Assistance to Wajir Water and Sewerage Company PHASE I - DESIGN REVIEW

Drawing Title: VIEWS

Consultant:



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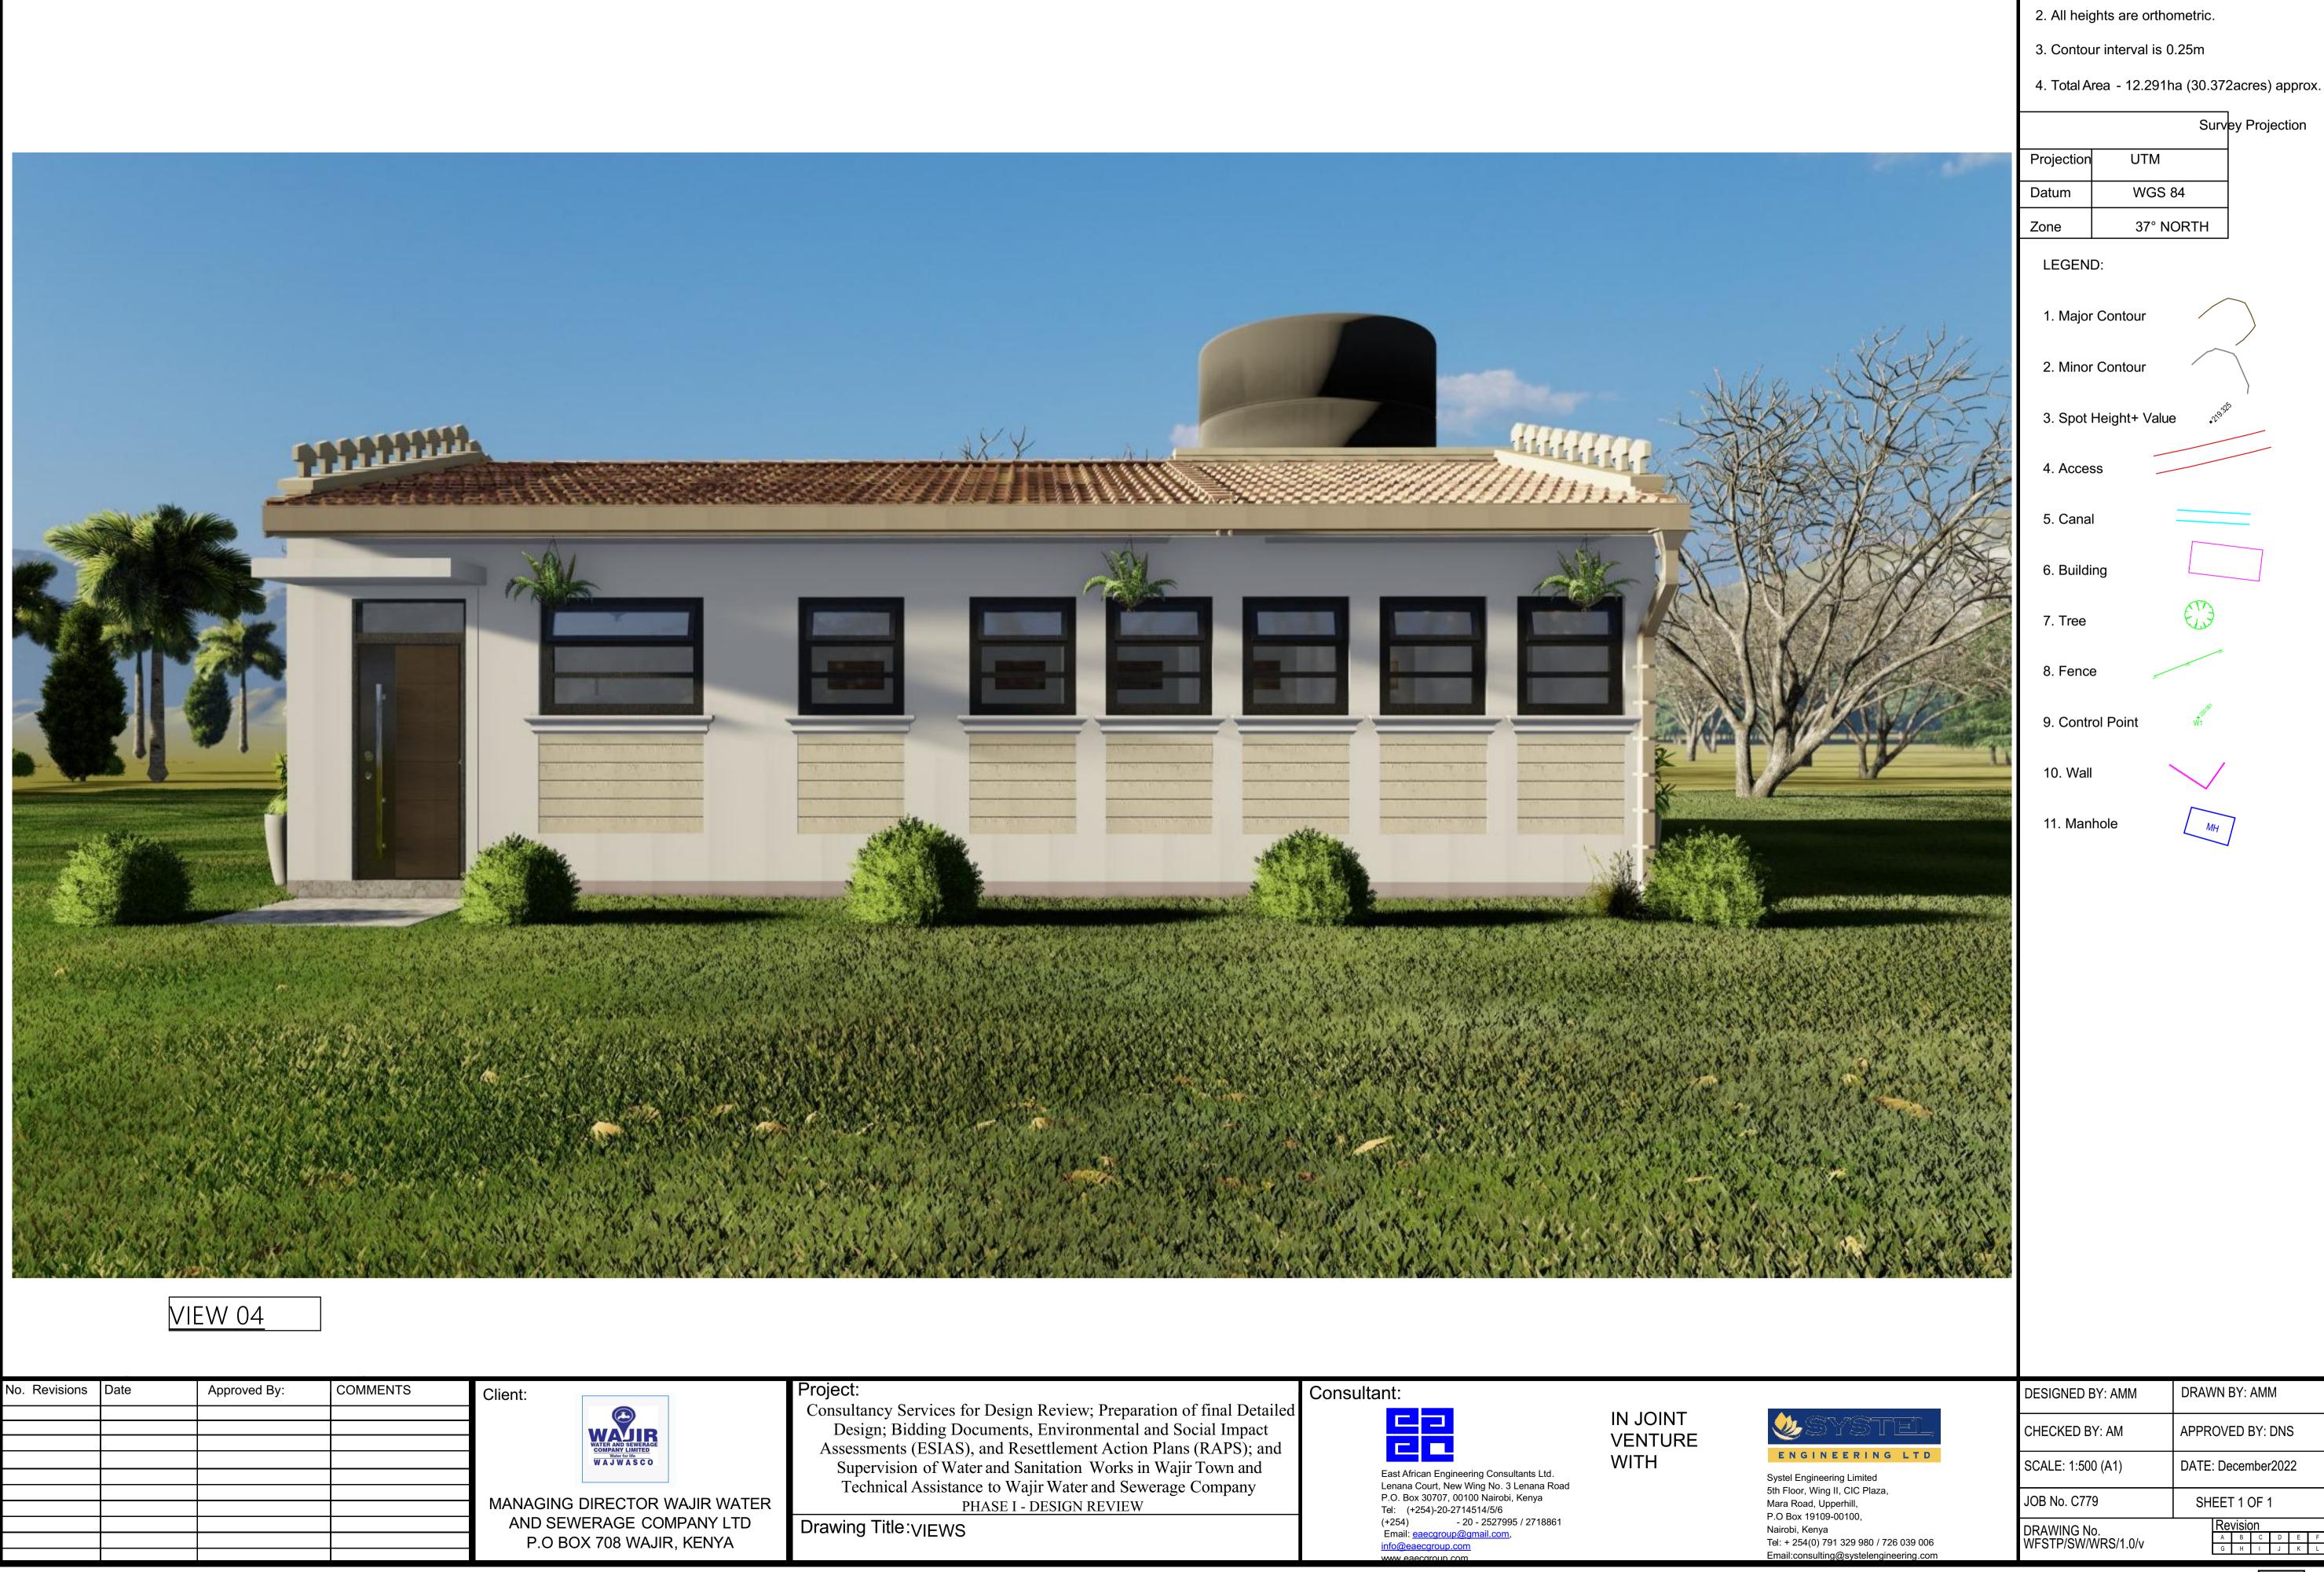
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	Surv	ey Projection
Projection	UTM	
Datum	WGS 84	
Zone	37° NORTH	

Datum WGS 84

Zone 37° NORTH

LEGEND:

1. Major Contour

2. Minor Contour

3. Spot Height+ Value
4. Access
5. Canal
6. Building
7. Tree
8. Fence
9. Control Point

10. Wall

11. Manhole

VIEW 05

Date	Approved By:	COMMENTS	Client:
			MANA
			ANE
			AINL
	Date	Date Approved By:	Date Approved By: COMMENTS

WATER AND SEWERAGE
COMPANY LIMITED
Water for III6
WA J W A S C O

MANAGING DIRECTOR WAJIR WATER AND SEWERAGE COMPANY LTD P.O BOX 708 WAJIR, KENYA

Project:

Consultancy Services for Design Review; Preparation of final Detailed Design; Bidding Documents, Environmental and Social Impact Assessments (ESIAS), and Resettlement Action Plans (RAPS); and Supervision of Water and Sanitation Works in Wajir Town and Technical Assistance to Wajir Water and Sewerage Company PHASE I - DESIGN REVIEW

Drawing Title: VIEWS

Consultant:




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	JOB No. C779	SHEET 1 OF 1						
	DRAWING No.	Revision						
	WFSTP/SW/WRS/1.0/v	A B C D E F G H I J K L						



Window Schedule							
Element ID	WD - 002 WD - 003 WD - 0		WD - 003				
Opening Name	me Vertical Multi-Sash Vertical Multi-Sash		Vertical Multi-Sash				
Quantity	2	2	12				
W x H Size	1,000×1,000	1,400×1,000	900×1,000				
Sill height	1.400	1.400	1.400				
Head height	2.400	2.400	2.400				
2D Symbol							
3D Back View							
	Door Sch	edule					
Opening Name	Door 25	Door 25	Door with Transom 25				
Quantity	2	10	2				
W x H Size	900×2,100	800×2,100	1,000×2,400				
Head height	2.100	2.100	2.400				
2D Symbol							

Client:

MANAGING DIRECTOR

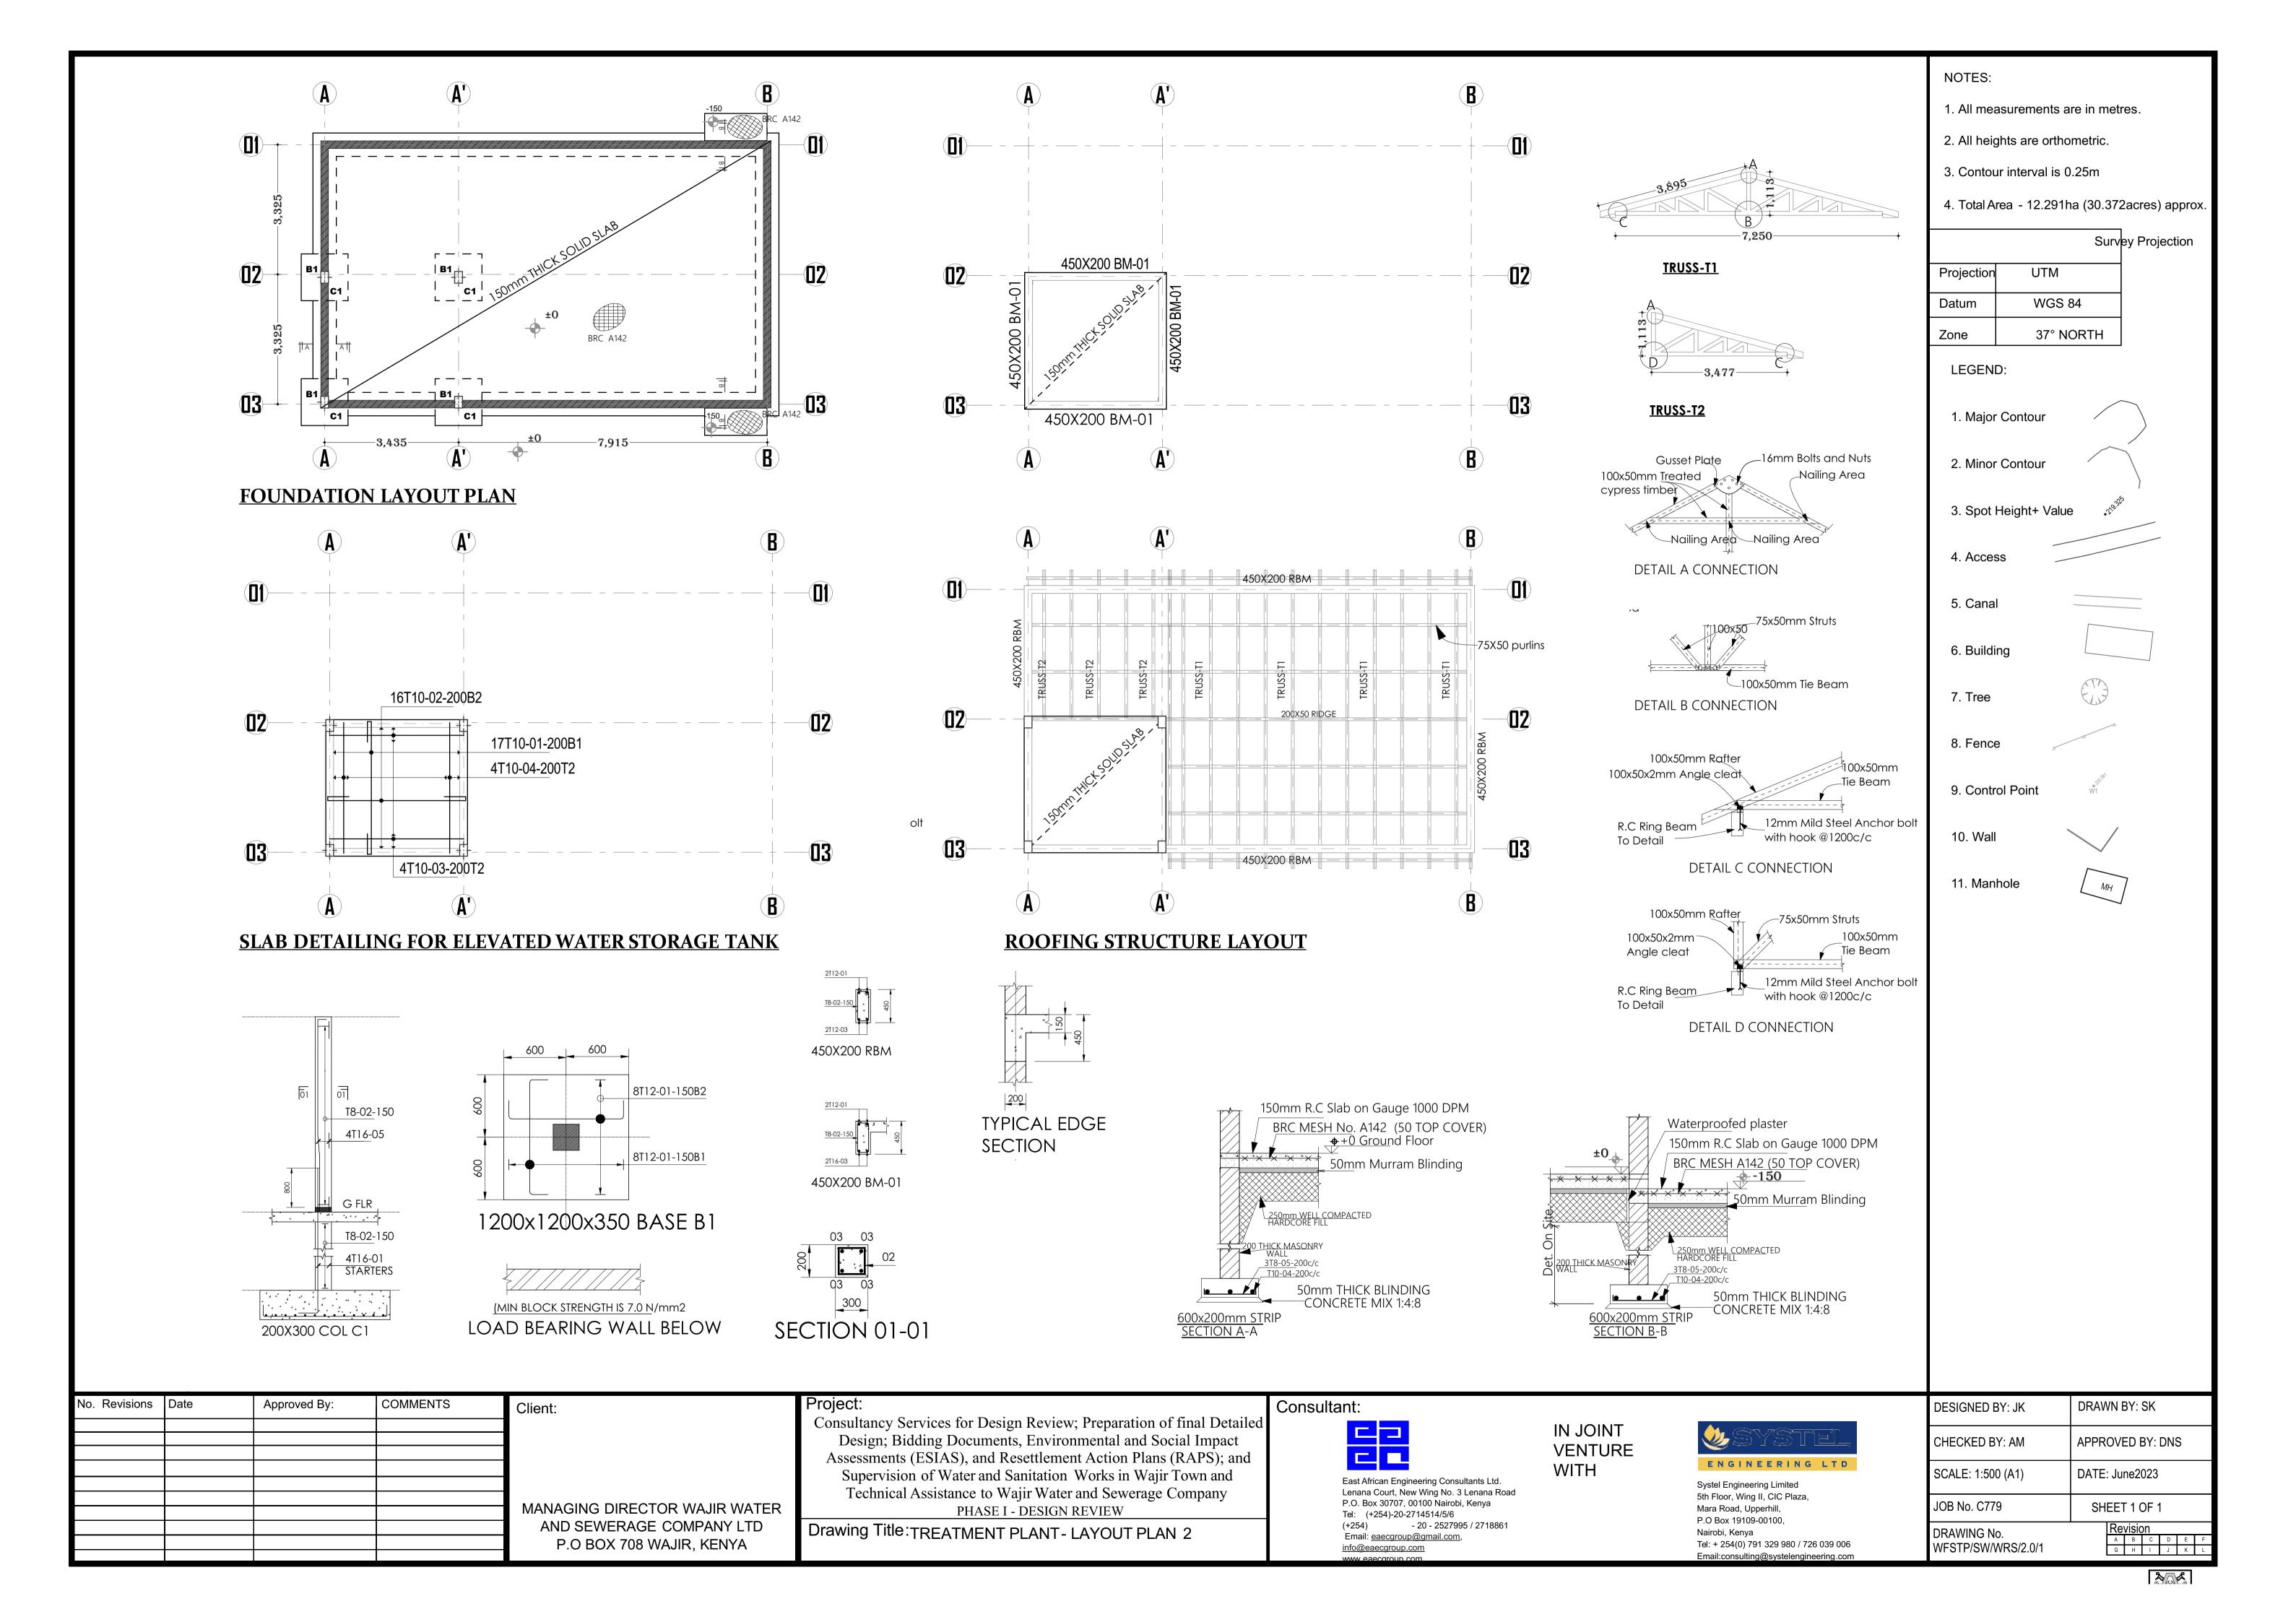WAJIR WATER AND SEWERAGE COMPANY LTD

P.O BOX 708 WAJIR, KENYA

Project:

Consultancy Se Ward And Service Sign Review; Preparation of final Detailed Design; Bidding Documents, En Ward Sco and Social Impact Assessments (ESIAS), and Resettlement Action Plans (RAPS); and Supervision of Water and Sanitation Works in Wajir Town and

PHASE I - DESIGN REVIEW

Technical Assistance to Wajir Water and Sewerage Company

Drawing Title: DOOR AND WINDOW SCHEDULE



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CHECKED BY: AM	APPROVED BY: SCW
SCALE: 1:500 (A1)	DATE: June2023
JOB No. C779	SHEET 1 OF 1

DRAWING No. WFSTP/SW/W&DS/01

NOTES

1. ALL DIMENSIONS ARE IN MM UNLESS OTHERWISE STATED 2. ALL CONCRETE TO BE CLASS 20/20 3. ALL PRECAST CONCRETE UNITS TO BS 556

CONCRETE FILLING CLASS 25/20
 VIBRATED AND CURED IN
 ACCORDANCE WITH THE APPROPRIATE SPECIFICATION CLAUSES.

 TOLERANCE ON OVERALL SIZE 3mm

ABBREVIATIONS

n.e. - NOT EXCEEDING
c/c - CENTRE TO CENTRE
MIN - MINIMUM


G.L. - GROUND LEVEL
mm - MILIMETER


TO - MILIMETER

EXT. DIA. - EXTERNAL DIAMETER
OD - OUTSIDE DIAMETER
ND - NOMINAL DIAMETER
RC - REINFORCED CONCRETE
TIO - TWISTED BAR TORM SIZE
NTS - NOT TO SCALE
CUM PER LIN. METER - CUBIC METER PER
LINEAR METER
CI - CASTI RON

CI - CAST IRON



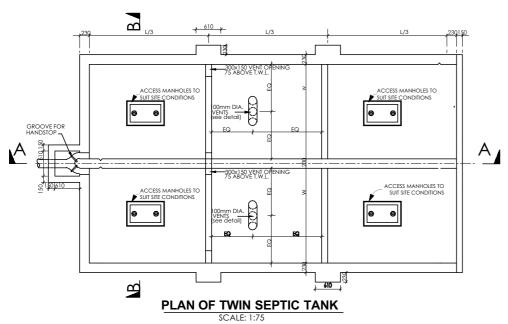

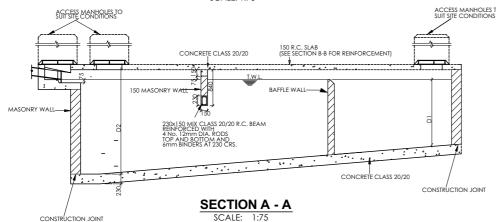

AT	300 CRS	+ + -	. / .	AT 150CRS.		1			
12mm DIA. BARS AT 150 CRS (25mm CONCRETE COVER) ⁻		T.W.L.		T.W.L. S		CONCRETE CLASS 25/20 230 MASONRY WALLING RENDERED INTERNALLY			
230 MASONRY WALLING RENDERED INTERNALLY AND EXTERNALLY WITH MIX — MORTAR WITH WATER PROOFING ADDITIVE	230	w	230	w 023	230	AND EXTERNALLY WITH MIX MORTAR WITH WATER PROOFING ADDITIVE	100mm DIA. 90 G.J BEND	100mm DIA. NIPPLE 100mm DIA. NIPPLE MOSQUITO WIRE GAUZE CONCRETE CLAS	\$ 25/20
				Li0mm DIA. BA BOTHWAYS 38				100mm DIA. G.I. PIPE (200mm LON WITH PUDDLE FLANGE	G)
		SECTI	ON B -	В			V	ENT PIPE DETAIL	

- 1. ALL DIMENSIONS ARE IN MM UNLESS OTHERWISE STATED 2. ALL CONCRETE TO BE CLASS 20/20 3. ALL PRECAST CONCRETE UNITS TO BS 556
- TO BS 556

 4. CONCRETE FILLING CLASS 25/20
 VIBRATED AND CURED IN
 ACCORDANCE WITH THE APPROPRIATE
 SPECIFICATION CLAUSES.

 5. TOLERANCE ON OVERALL SIZE 3mm

ABBREVIATIONS

- ABBREVIATIONS

 n.e. NOT EXCEEDING

 c/c CENTRE TO CENTRE

 MIN MINIMUM

 G.L GROUND LEVEL

 mm MILIMETER

 TO OUTSIDE DIAMETER

 OD OUTSIDE DIAMETER

 ND NOMINAL DIAMETER

 RC REINFORCED CONCRETE

 TIO TWISTED BAR TORM SUE

 NTS NOT TO SCALE

 CUM PER LIN. METER CUBIC METER PER

 LINEAR METER

 CI CAST IRON
- CI CAST IRON

Consultant:



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CAPACITY

CU METRES

31.80 NOTES

1675

IN JOINT **VENTURE** WITH

1830

1525

1. ALL CONCRETE MIX TO BE CLASS 20/20 UNLESS OTHERWISE SPECIFIED 2. COVER TO ALL REINFORCEMENT 40mm WALLS AND BASE, 25mm

1905



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	CHECKED BY: AM	APPROVED BY: SCV			
	SCALE: 1:500 (A1)	DATE: June2023			
	JOB No. C779	SHEET 1 OF 1			
i	DD AMENICAL	Revision			

DRAWING No. WFSTP/SW/WRS/1.0/5





WAJIR WATER AND SEWERAGE COMPANY LTD

10mm DIA. BARS


P.O BOX 708 WAJIR, KENYA

150 R.C SLAB


Consultancy Services for Design Review; Preparation of final Detailed Design; Bidding Documents, Environmental and Social Impact Assessments (ESIAS), and Resettlement Action Plans (RAPS); and Supervision of Water and Sanitation Works in Wajir Town and Technical Assistance to Wajir Water and Sewerage Company

PHASE I - DESIGN REVIEW


Drawing Title: SEPTIC TANK

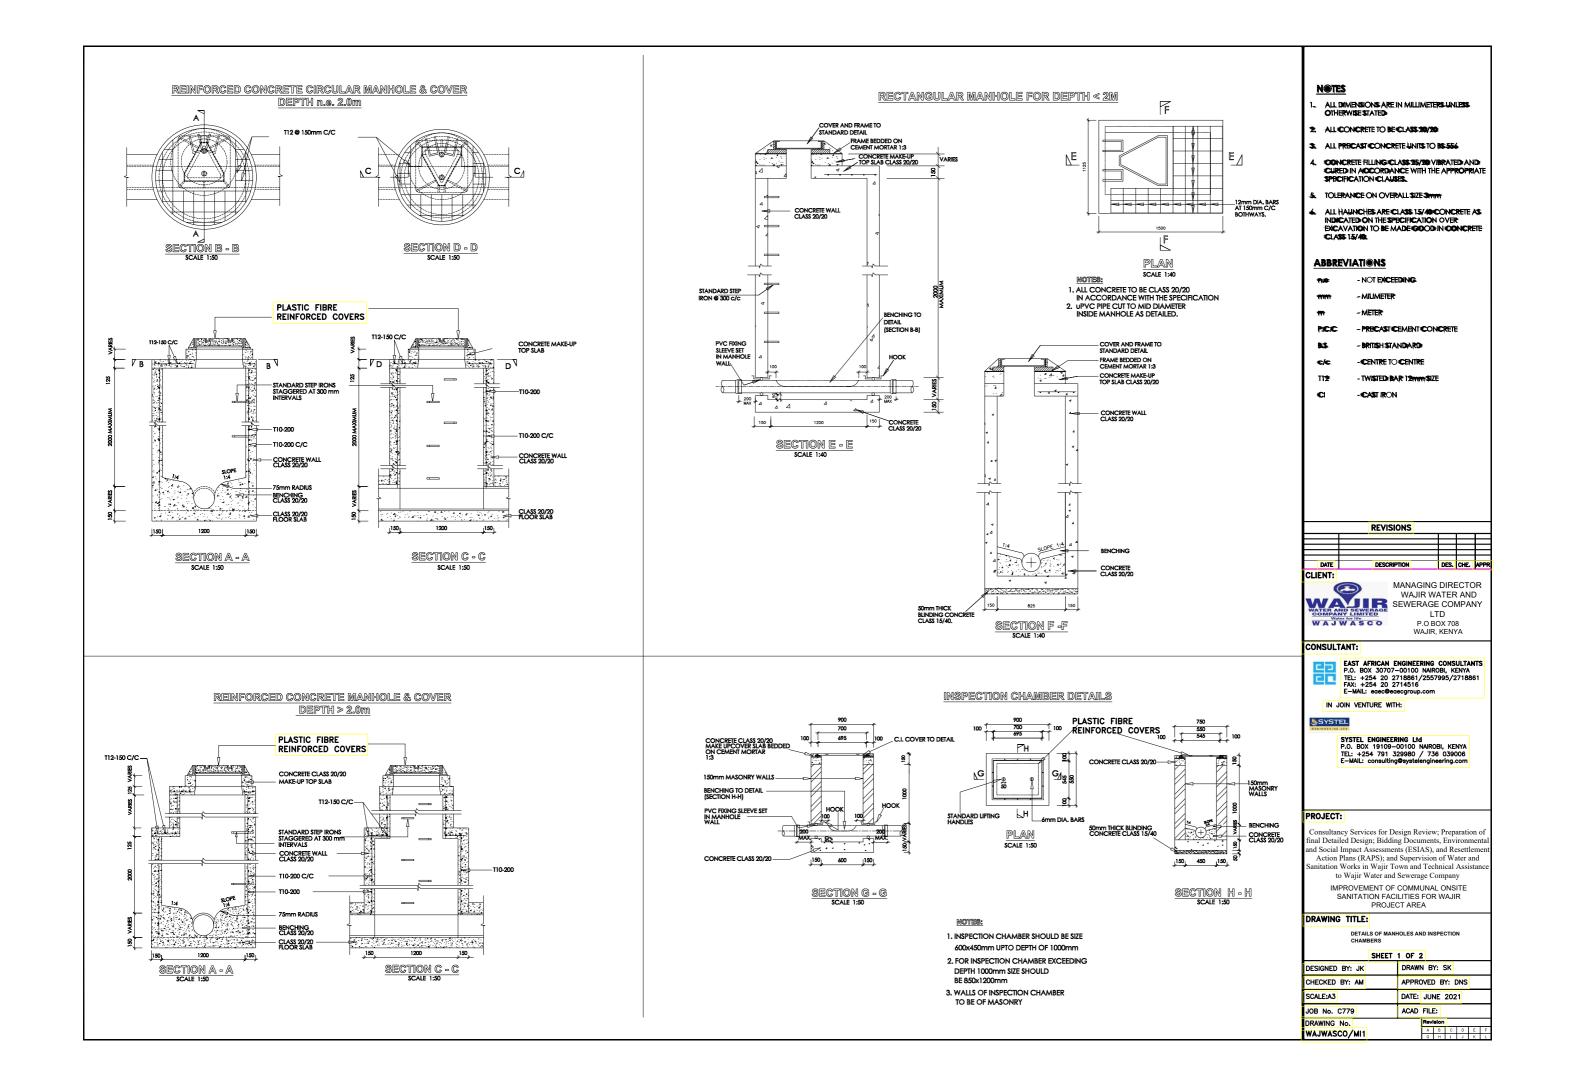

DETAILS OF TRIANGULAR CONCRETE FILLED MANHOLE COVER FOR FOUL SEWER

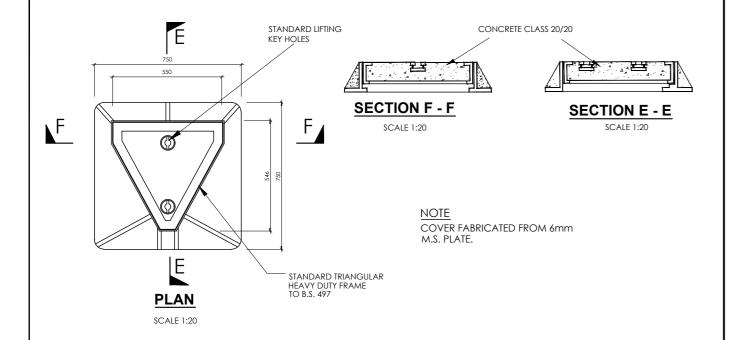


PLASTIC FIBRE REINFORCED **COVER FOR MANHOLES**

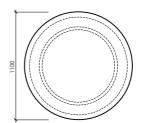

SECTIONAL ELEVATION

SCALE 1:40

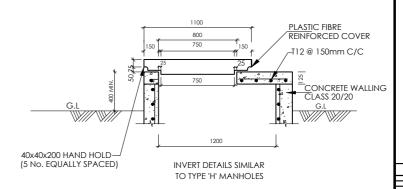

PLASTIC FIBRE REINFORCED **COVER - PLAN**

- ALL DIMENSIONS ARE IN MILLIMETERS UNLESS.
 OTHERWISE STATED
- 2. ALL CONCRETE TO BE €LASS 20/20
- ALL PRECAST CONCRETE UNITS TO BS-554
- CONCRETE FILLING-CLASS 25/30 VIBRATED AND CURED IN ACCORDANCE WITH THE APPROPRIATE SPECIFICATION CLAUSES.
- TOLERANCE ON OVERALL SIZE Smith
- ALL HAUNCHES ARE-CLASS 15/40-CONCRETE AS INDICATED ON THE SPECIFICATION OVER EXCAVATION TO BE MADE-GOOD IN CONCRETE CLASS 15/40.

ABBREVIATIONS

- NOT EXCEEDING

-MILIMETER

-METER

-PRECAST CEMENT CONCRETE


- BRITISH STANDARD

-CENTRE TO CENTRE

- TWISTED BAR 12mm SIZE ΠŻ

€I -CAST IRON

REVISIONS

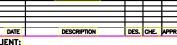



MANAGING DIRECTOR WAJIR WATER AND P.O BOX 708 WAJIR, KENYA

CONSULTANT:



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IMPROVEMENT OF COMMUNAL ONSITE SANITATION FACILITIES FOR WAJIR PROJECT AREA

DRAWING TITLE:


DETAILS OF MANHOLES AND INSPECTION

SHEET 2 OF 2

DRAWN BY: SK

DESIGNED BT: JK	DRAWN BI: 3K							
CHECKED BY: AM	APPROVED BY: DNS							
SCALE:A3	DATE: JUNE 2021							
JOB No. C779	ACAD FILE:							
DRAWING No.	Revision							
WAJWASCO/MI2	A B C D E F							

DETAILS OF BACKDROPS FOR MANHOLES

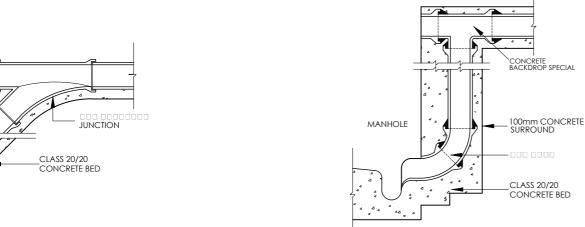


SIDE ENTRANCE BACKDROP SCALE 1:20

→ 00mm CONCRETE

CLASS 20/20

CONCRETE BED

SCALE 1:20

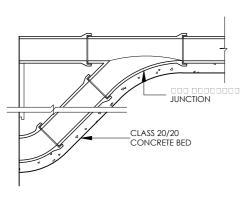


MANHOLE DROPLEAD

SCALE 1:20

END ENTRANCE BACKDROP

CONCRETE PIPE BEDS AND HAUNCHES

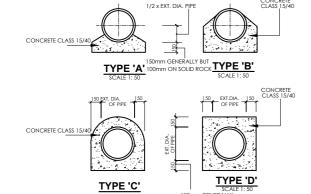


PIPE	PIPE	HAUNCH TYPE									
DIAMETER	THICKNESS	1	Α'	1	B'	1	C'	,D,			
mm	mm	100mmBED	50mmBED 1	0mmBED 15	mmBED 100	mmBED 150r	mBED 100m	mBED	150mmBEI		
100	25.4	0.0556	0.0791	0.0799	0.1034	0.1431	0.1666	0.1653	0.1888		
150	25.4	0.0642	0.0904	0.0845	0.1107	0.1706	0.1968	0.1981	0.2242		
225	28.57	0.0783	0.1053	0.1262	0.1557	0.2155	0.2450	0.2525	0.2821		
300	31.75	0.0929	0.1277	0.1557	0.1905	0.2617	0.2965	0.3100	0.3448		
375	34.92	0.1080	0.1470	0.1864	0.2255	0.3094	0.3485	0.3702	0.4093		
450	38.10	0.1253	0.1689	0.2208	0.2644	0.3623	0.4059	0.4382	0.4818		
525	44.45	0.1433	0.1916	0.2564	0.3046	0.4169	0.4652	0.5052	0.5536		
600	50.80	0.1619	0.2147	0.2943	0.3471	0.4731	0.5259	0.5844	0.6372		
675	53.98	0.1804	0.2375	0.3310	0.3880	0.5270	0.5841	0.6570	0.7141		
750	57.15	0.1986	0.2600	0.3582	0.4295	0.5823	0.6436	0.7325	0.7938		
900	63.50	0.2378	0.3077	0.4479	0.5161	0.6973	0.7672	0.8922	0.9620		
1050	69.85	0.2810	0.3605	0.4945	0.5741	0.8181	0.8977	1.0635	1.1431		
1200	76.20	0.3291	0.4161	0.6230	0.7101	0.9448	1.0318	1 2466	1.3336		

CONCRETE QUANTITIES IN BED AND SURROUNDS FOR O. G. CONCRETE PIPES (CU.M.PER LIN. METER)


DEPTH TO THE	PIPE DIAMETER IN mm										
TOP OF PIPE	150	225	300	375	450	525	600	675	750	(>750)	
<1.25M IN ROADS <1.00M ELSEWHERE		TYPE `C'									
<4.00M	MAY BE	TYPE 'A' (CONCRETE BED) MAY BE DELETED AT THE DISCRETION OF THE ENGINEER TYPE 'B'							BY ENGINEER		
>4.00M		TYPE 'B'									
>6.00M OR IN HEADING		TYPE 'C' OR 'D' AS DIRECTED							AS SPECIFIED		

TYPE OF BED AND HAUNCH TO BE USED

Y - JUNCTION DETAILS

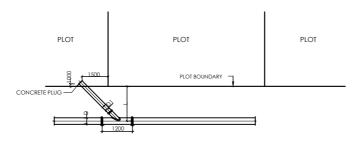


ROAD RESERVE / WAYLEAVE

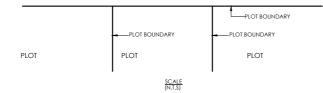


- NOTES: L TO BE DETERMINED ON SITE D - VARIES BETWEEN 160 - 250mm
- D1 160mm DIA uPVC SEWER PIPE

UNDER ROAD OR VERGE

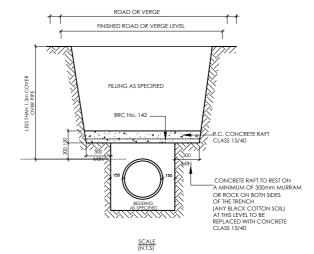

BEDDING AND JOINTING OF FLEXIBLE JOINTED CONCRETE PIPES - TYPE 'BO'

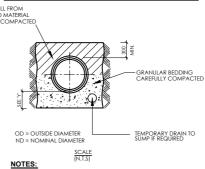

1. DIMENSION 'Y'
IN ROCK OR MIXED SOILS CONTAINING ROCK BANDS BOULDERS OR STONES OR OTHER IRREGULAR HARD SPOTS. Y= 1/4 OD UNDER BARRELS WITH MIN. 150mm

(PLUS 12mm PER 300mm OF COVER IN EXCESS OF 4.85m)

UNDER BOTH BARRELS AND SOCKETS IN MACHINE DUG UNIFORM SOILS

Y= OD UNDER BARRELS WITH MIN. 100mm UNDER BOTH BARRELS AND SOCKETS

2.FOR GRANULAR BED AND SURROUND TO PIPES UNIFORMLY GRADED GRANULAR MATERIAL SUCH AS GRAVEL OR BROKEN STONE TO BE USED, IT SHOULD PASS 12mm SIEVE OR SHALL BE RETAINED ON 5mm SIEVE.

3.TRENCHES MUST BE KEPT TO DESIGN WIDTH

FLEXIBLY JOINTED CONCRETE PIPES

REVISIONS

ALL DIMENSIONS ARE IN MILLIMETERS UNLESS. OTHERWISE STATED 2. ALL CONCRETE TO BE CLASS 20/20 3. ALL PRECAST CONCRETE UNITS TO BESSE 4. CONCRETE FILLING-CLASS-25/20 VIRRATED AND CURED IN ACCORDANCE WITH THE APPROPRIATE SPECIFICATION CLAUSES.

ALL HAUNCHES ARE CLASS 15/40/00NCRETE AS INDICATED ON THE SPECIFICATION OVER EMCAVATION TO BE MADE GOOD IN CONCRETE CLASS 15/40.

- NOT EXCEEDING -CENTRE TO CENTRE

- GROUND LEVEL

- EXTERNAL DIAMETE

- TWISTED BAR 18

-NOT TO SCALE

CULM PER LINL METER - CUBIC METER PER LINEAR METER

-UNPLASTICISED POLYVINYLICHLORIDE

-MFTER

ABBREVIATIONS

EXTLDIA





MANAGING DIRECTOR WAJIR WATER AND P.O BOX 708 WAJIR, KENYA

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DRAWING TITLE:

SHEET 1

DESIGNED BY: JK	DRAW	N B	Y: \$	SK				
CHECKED BY: AM	APPROVED BY: DNS							
SCALE:A3	DATE: JUNE 2021							
JOB No. C779	ACAD	FILI	E:					
DRAWING No.		Revi	ision					
WAJWASCO/MI3		Α	В	С	D	Е	F	
THOTHASCO/ MIS		G	н	1	J	к	L.	